SITE DEVELOPMENT PLAN SUBMITTAL THE RADY COLLEGE OF COMPUTER SCIENCE AND ENGINEERING AT WSCU

LEGAL DESCRIPTION:

ALL BLOCK 2, BOUTCHER'S ADDITION TO GUNNISON, AND BLOCK 9, BOUTCHER'S ADDITION TO GUNNISON, WHICH IS ALSO DESCRIBED AS BLOCK 9, CUENIN'S SUB-DIVISION OF BLOCKS 7-8 & 9, BOUTCHER'S ADDITION TO GUNNISON, IN ACCORDANCE WITH THE OFFICIAL PLATS THEREOF RECORDED IN THE OFFICE OF GUNNISON COUNTY CLERK AND RECORDER.

VICINITY MAP



NORTH

SITE DATA:

NUMBER OF BUILDINGS BUILDING HEIGHT 61'-0" TOTAL BUILDING COVERAGE 32,425 SF TOTAL BUILDING GFA 81,899 SF

PARKING DATA:

NEW **EXISTING** 195 ACCESSIBLE 253

SHEET INDEX

COVER SHEET SDP-02 PRELIMINARY GRADING PLAN PRELIMINARY UTILITY PLAN SDP-06 LANDSCAPE PLAN LANDSCAPE DETAILS SCHEMATIC BUILDING ELEVATIONS SCHEMATIC BUILDING ELEVATIONS

SITE LIGHTING PLAN

PROJECT CONTACTS

AUTHORIZED REPRESENTATIVE FOR WESTERN OPPORTUNITY FUND

44 INVERNESS DRIVE EAST, BLDG D, SUITE 100 ENGLEWOOD, CO 80112 PHONE: 303-694-4080 CONTACT: RICK WATKINS

ARCHITECT

SDP-10

FARNSWORTH GROUP, INC. 5613 DTC PARKWAY, SUITE 1100 GREENWOOD VILLAGE, CO 80111 PHONE: 303-692-8838 CONTACT: ROB STETTNER EMAIL: RSTETTNER@F-W.COM **PRIMARY CONTACT**

SURVEY

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CIVIL

KIMLEY-HORN 4582 SOUTH ULSTER STREET, SUITE 1500 DENVER, CO 80237 PHONE: 303-692-8838 CONTACT: MATTHEW DEAVER
EMAIL: MATTHEW.DEAVER@KIMLEY-HORN.COM

LANDSCAPE

FARNSWORTH GROUP, INC. 5613 DTC PARKWAY, SUITE 1100 GREENWOOD VILLAGE, CO 80111 PHONE: 303-692-8838 CONTACT: CHAD HERD EMAIL: CHERD@F-W.COM

ELECTRICAL

FARNSWORTH GROUP, INC. 4755 FORGE ROAD, SUITE 150 COLORADO SPRINGS, CO 80907 PHONE: 719-590-6658 CONTACT: AMANDA OCCHI EMAIL: AOCCHI@F-W.COM

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Engineers | Architects | Surveyors | Scientists

DATE: DESCRIPTION:

06/08/2018 SDP SUBMITTAL #1 07/05/2018 SDP SUBMITTAL #2

MESA PROPERTIES

THE RADY COLLEGE OF COMPUTER SCIENCE AND **ENGINEERING AT** WSCU


777 GEORGIA AVE GUNNISON, CO

DATE: 05/08/2018 DESIGN/DRAWN: **REVIEWED:**

SDP COVER SHEET

0180432.00


PROJECT NO.:

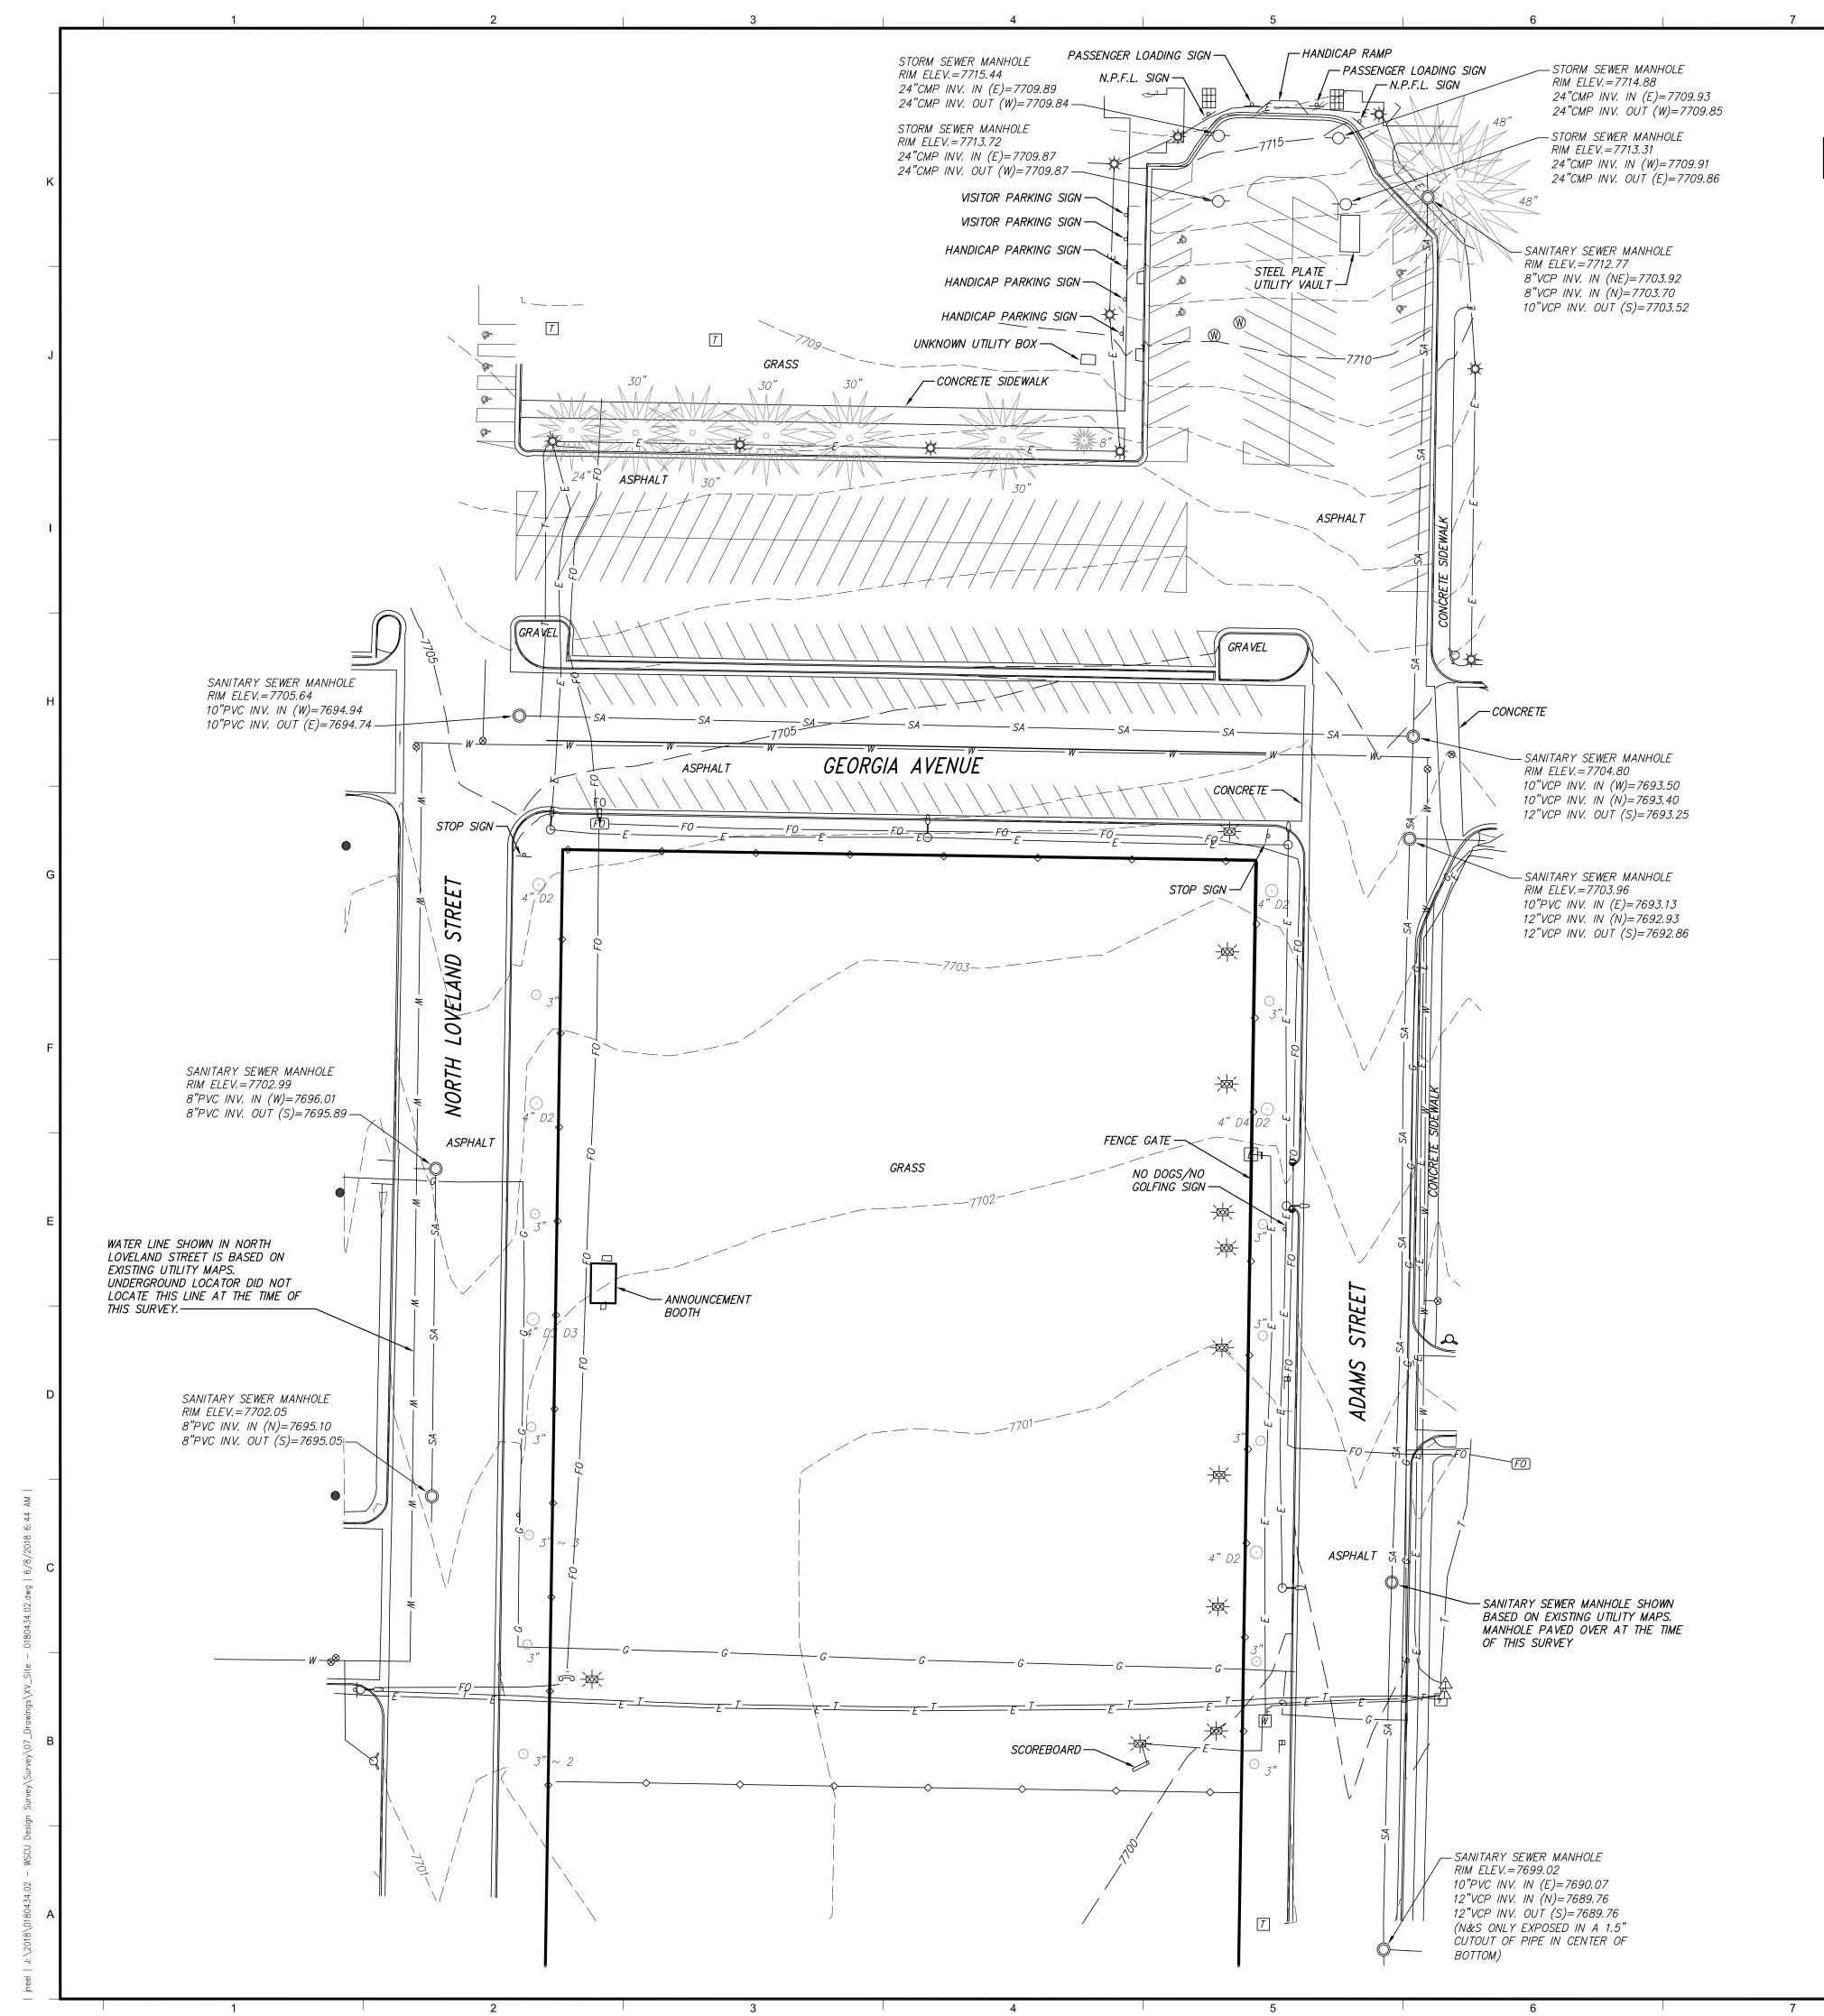

Existing Conditions

LEGAL DESCRIPTION:

ALL BLOCK 2, BOUTCHER'S ADDITION TO GUNNISON, AND BLOCK 9, BOUTCHER'S ADDITION TO GUNNISON, WHICH IS ALSO DESCRIBED AS BLOCK 9, CUENIN'S SUB-DIVISION OF BLOCKS 7-8 & 9, BOUTCHER'S ADDITION TO GUNNISON, IN ACCORDANCE WITH THE OFFICIAL PLATS THEREOF RECORDED IN THE OFFICE OF GUNNISON COUNTY CLERK AND RECORDER.

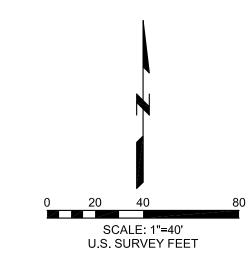

<u>LEGEND</u>

STORM SEWER INLET COMMUNICATIONS PEDESTAL WATER MANHOLE PARKING LOT LIGHT DECIDUOUS TREE EVERGREEN TREE STREET LAMP

FIBER OPTIC BOX WATER VALVE IRRIGATION PEDESTAL FLAGPOLE TRANSFORMER

FIBER OPTIC MARKER COMMUNICATIONS BOX ELECTRIC SHUT OFF SPRINKLER BOX BOLLARD FIRE HYDRANT

SA SANITARY SEWER LINE -----E------ ELECTRIC LINE — G — GAS LINE -----FO ------ FIBER OPTIC LINE → METAL FENCE STORM SEWER LINE ------T------ COMMUNICATIONS LINE ----- W ----- WATER LINE

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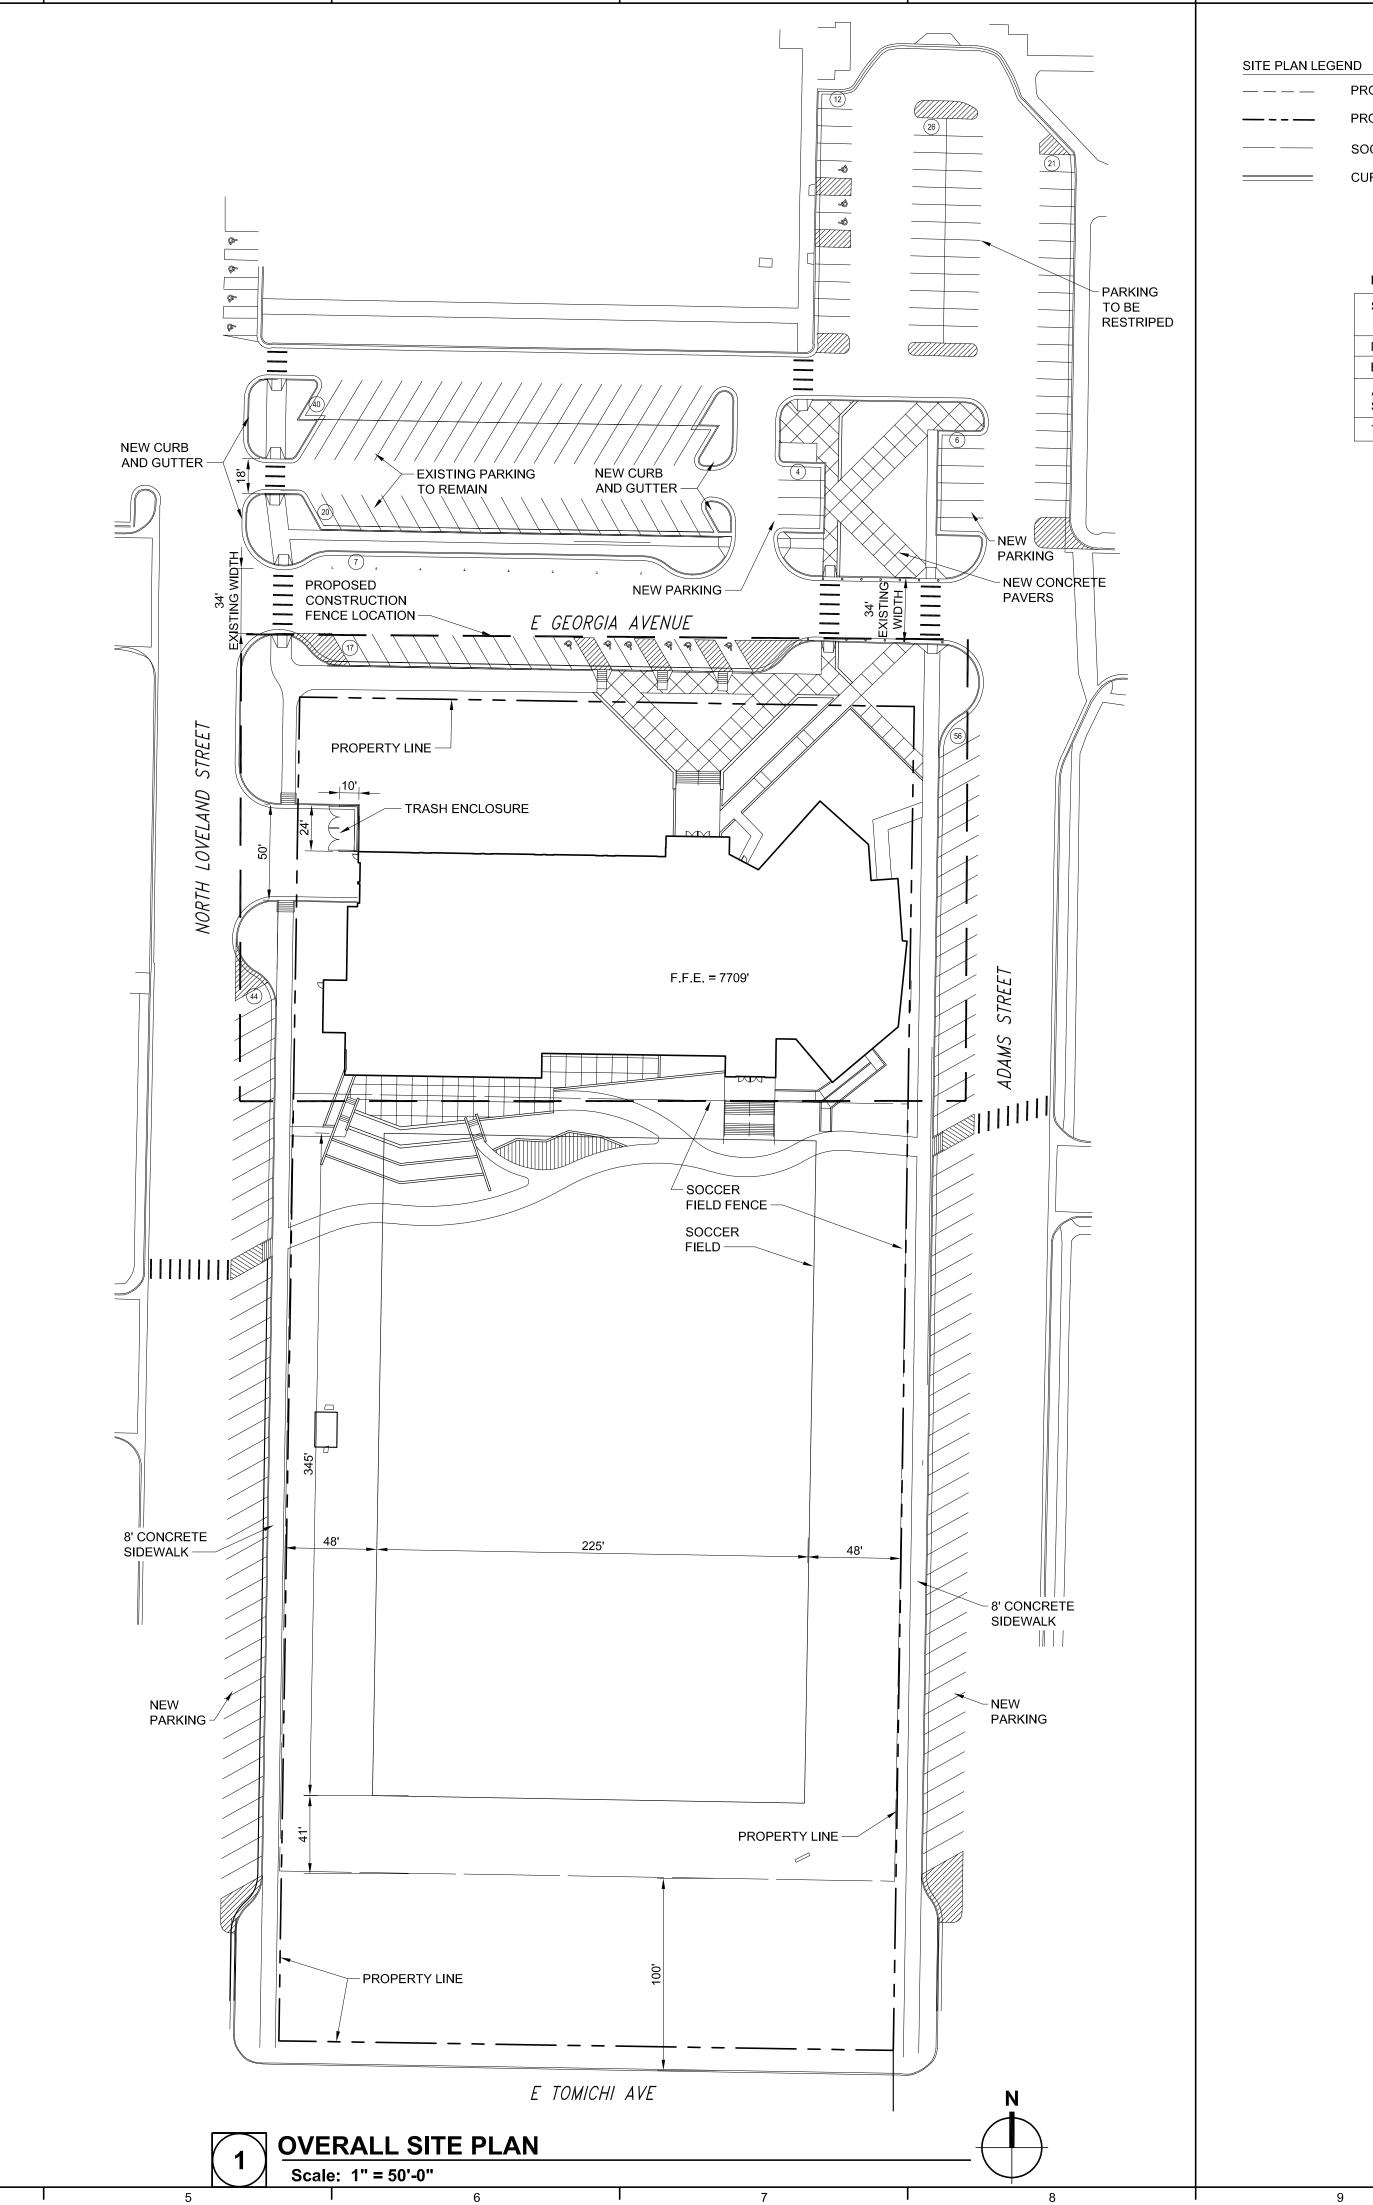
06/08/2018 SDP SUBMITTAL #1 07/05/2018 SDP SUBMITTAL #2

05/11/2018 DESIGN/DRAWN: ZJT AJW REVIEWED: FIELD BOOK NO.:

| Topographic Survey

SDP-02

PROJECT NO.:



PROPOSED CONSTRUCTION FENCE LOCATION

PROPERTY LINE

SOCCER FEILD FENCE

CURB AND GUTTER

PARKING CALCULATIONS

SPACE	TOTAL STALLS PROVIDED
NEW	58
EXISTING	195
ACCESSIBLE SPACES	9
TOTAL	253



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MESA PROPERTIES

THE RADY COLLEGE OF COMPUTER SCIENCE AND **ENGINEERING AT** WSCU


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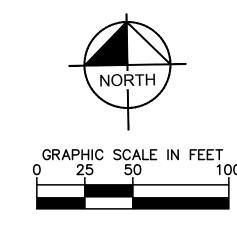
DATE:	05/08/2018
DESIGN/DRAWN:	МС
REVIEWED:	RS

OVERALL SITE PLAN

SDP-03

PROJECT NO.:



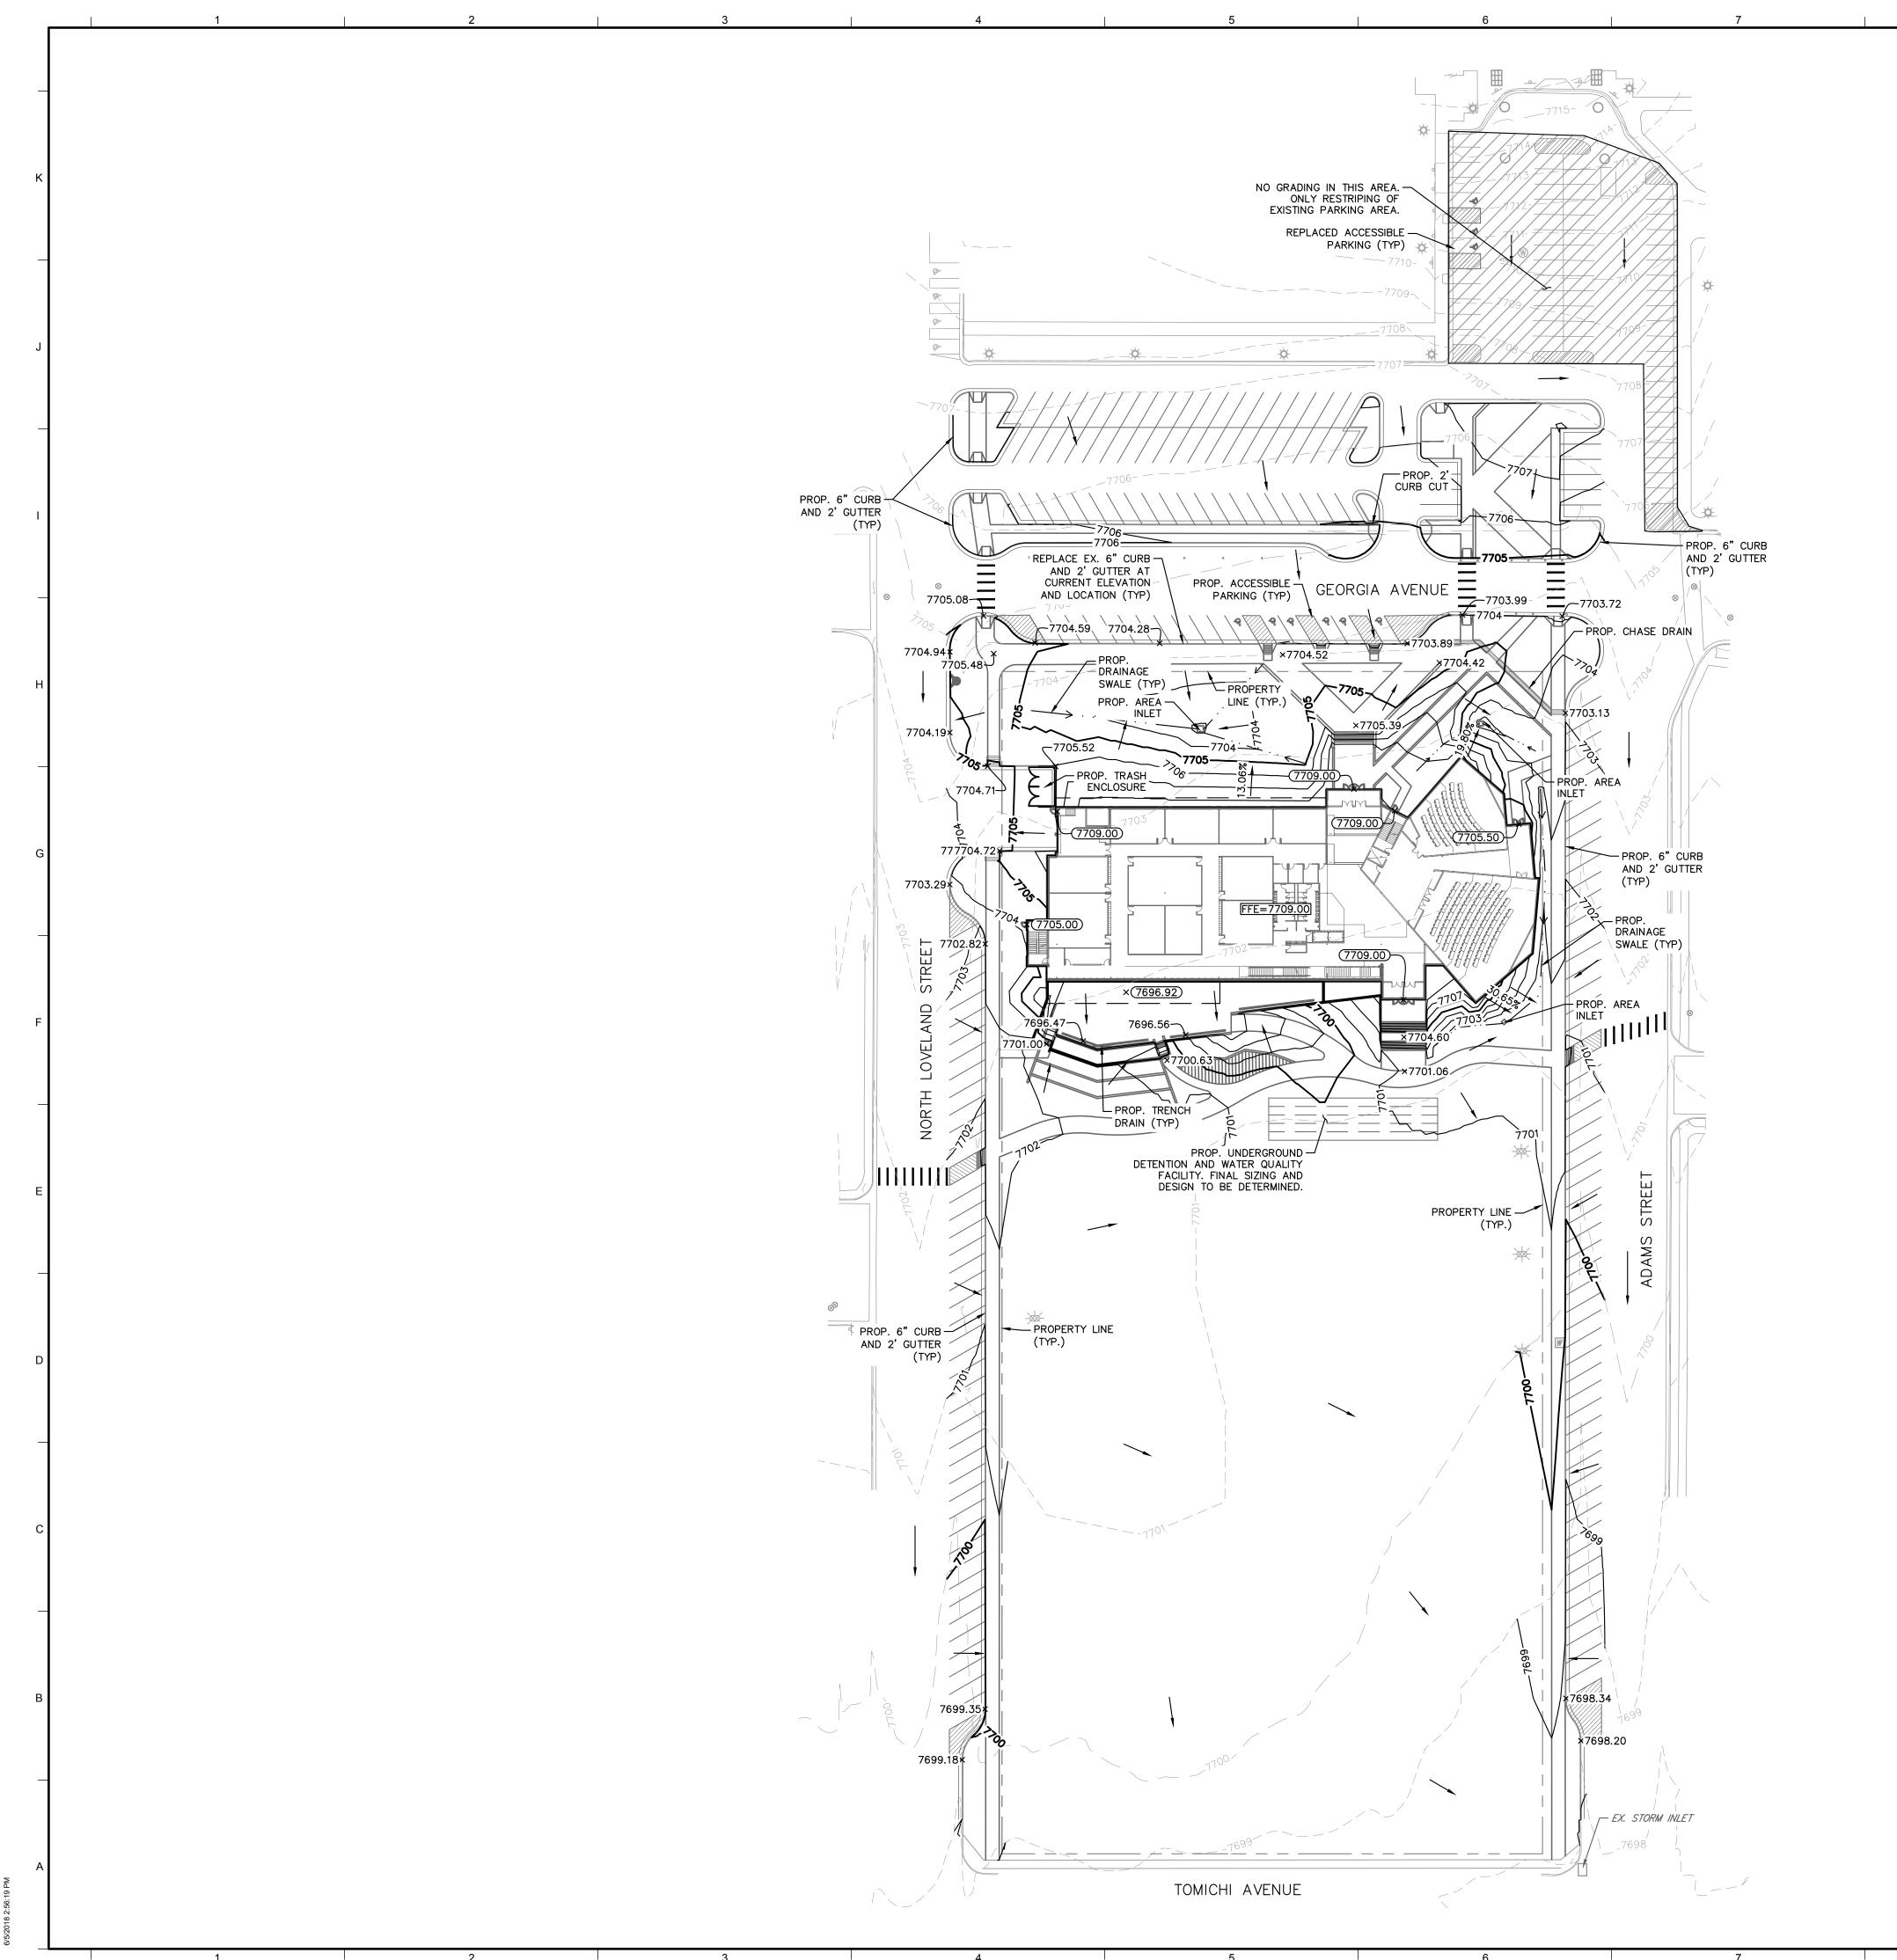

MILL AND OVERLAY EXISTING PAVEMENT

GRADING LEGEND

PROPOSED ROW/PROPERTY BOUNDARY

EXISTING ROW

EXISTING MINOR CONTOUR

EXISTING MAJOR CONTOUR

PROPOSED MINOR CONTOUR

PROPOSED MAJOR CONTOUR


BUILDING ABOVE

HP
HIGH POINT
EX
EXISTING
FFE
FINISHED FLOOR ELEVATION
TG
TOP OF GRATE

RESTRIPING ONLY AREA

GRADING NOTES

- 1. CONTRACTOR MAY BE REQUIRED TO PROVIDE ADDITIONAL FILL MATERIAL TO ACCOMMODATE THE REMOVAL OF EXISTING STRUCTURES AS REQUIRED.
- 2. THE CONTRACTOR IS SPECIFICALLY CAUTIONED THAT THE LOCATION AND/OR ELEVATION OF EXISTING UTILITIES AS SHOWN ON THESE PLANS IS BASED ON RECORDS OF THE VARIOUS UTILITY COMPANIES, AND WHERE POSSIBLE, MEASUREMENTS TAKEN IN THE FIELD. THE INFORMATION IS NOT TO BE RELIED ON AS BEING EXACT OR COMPLETE. THE CONTRACTOR MUST CALL THE APPROPRIATE UTILITY COMPANIES AT LEAST 72 HOURS BEFORE ANY EXCAVATION TO REQUEST EXACT FIELD LOCATION OF UTILITIES. IT SHALL BE THE RESPONSIBILITY OF THE CONTRACTOR TO RELOCATE ALL EXISTING UTILITIES WHICH CONFLICT WITH THE PROPOSED IMPROVEMENTS SHOWN ON THE PLANS.
- 3. ALL CUT OR FILL SLOPES SHALL BE 4:1 OR FLATTER UNLESS OTHERWISE NOTED.
- 4. THE CONTRACTOR SHALL ADHERE TO ALL TERMS & CONDITIONS AS OUTLINED IN THE EPA OR APPLICABLE STATE GENERAL N.P.D.E.S. PERMIT FOR STORM WATER DISCHARGE ASSOCIATED WITH CONSTRUCTION ACTIVITIES.
- 5. CONTRACTOR SHALL ADJUST AND/OR CUT EXISTING PAVEMENT AS NECESSARY TO ASSURE A SMOOTH FIT AND CONTINUOUS GRADE.
- 6. CONTRACTOR SHALL ASSURE POSITIVE DRAINAGE AWAY FROM BUILDINGS FOR ALL NATURAL AND PAVED AREAS.
- 7. ALL UNSURFACED AREAS DISTURBED BY GRADING OPERATION SHALL RECEIVE 4 INCHES OF TOPSOIL. CONTRACTOR SHALL APPLY STABILIZATION FABRIC TO ALL SLOPES 4H:1V OR STEEPER. CONTRACTOR SHALL STABILIZE DISTURBED AREAS IN ACCORDANCE WITH GOVERNING SPECIFICATIONS UNTIL A HEALTHY STAND OF VEGETATION IS OBTAINED.
- 8. CONTRACTOR SHALL EXCAVATE EXISTING PAVEMENT/SIDEWALK AREAS THAT ARE TO BE LANDSCAPED A MINIMUM OF 30" OR AS DEEP AS NECESSARY TO ENSURE ALL STONE BASE / PAVEMENT MATERIAL IS REMOVED (WHICHEVER IS GREATER) AND BACKFILL WITH CLEAN/DRAINING SAND TO WITHIN 4" OF TOP OF CURB TO ENSURE PROPER SOIL FOR PLANT MATERIALS.
- 9. THE CONTRACTOR SHALL GRADE THE SITE TO THE ELEVATIONS INDICATED AND SHALL REGRADE WASHOUTS WHERE THEY OCCUR AFTER EVERY RAINFALL UNTIL A GRASS STAND IS WELL ESTABLISHED OR ADEQUATE STABILIZATION OCCURS.
- 10. ALL AREAS INDICATED AS PAVEMENT SHALL BE CONSTRUCTED IN ACCORDANCE WITH THE TYPICAL PAVEMENT SECTIONS AS INDICATED BY THE CITY OF GUNNISON.
- 11. WHERE NEW PAVEMENT MEETS THE EXISTING PAVEMENT, THE CONTRACTOR SHALL SAWCUT THE FULL DEPTH OF EXISTING PAVEMENT FOR A SMOOTH AND STRAIGHT JOINT AND MATCH THE EXISTING PAVEMENT ELEVATION WITH THE PROPOSED PAVEMENT UNLESS OTHERWISE INDICATED.
- 12. WHERE NEW WORK MEETS EXISTING FEATURES TO REMAIN, FIELD CHECK ALL DIMENSIONS AND ELEVATIONS BEFORE PROCEEDING WITH CONSTRUCTION. NOTIFY ENGINEER IMMEDIATELY OF ANY DISCREPANCIES IN WRITING.
- 13. PROVIDE SMOOTH VERTICAL CURVES THROUGH HIGH AND LOW POINTS INDICATED BY SPOT ELEVATIONS. PROVIDE UNIFORM SLOPES BETWEEN NEW AND EXISTING GRADES. AVOID RIDGES AND DEPRESSIONS.
- 14. NEW ELEVATIONS INDICATE FINISHED CONDITIONS. FOR ROUGH GRADING ELEVATIONS ALLOW FOR THICKNESS OF NEW PAVING (ROADS, WALKS, DRIVE, ETC.) OR TOPSOIL AS SHOWN.
- 15. SIX (6") INCHES OF TOPSOIL SHALL BE PLACED ON ALL NON-BUILD AREAS WHERE NEW GRADING IS SHOWN ON PLANS, OR IN ACCORDANCE WITH THE LANDSCAPE PLANS, WHICHEVER IS MORE STRINGENT.

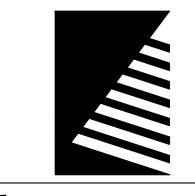

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DATE: DESCRIPTION:

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PROJECT:

MESA PROPERTIES

THE RADY COLLEGE
OF COMPUTER
SCIENCE AND
ENGINEERING AT WSCU

777 GEORGIA AVE GUNNISON, CO

DATE: 07/05/2018

DESIGN/DRAWN: MCD


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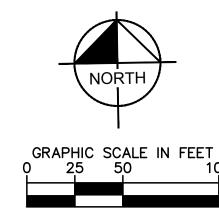
PRELIMINARY GRADING PLAN

SHEET NUMBER:


SDP-04

PROJECT NO.:



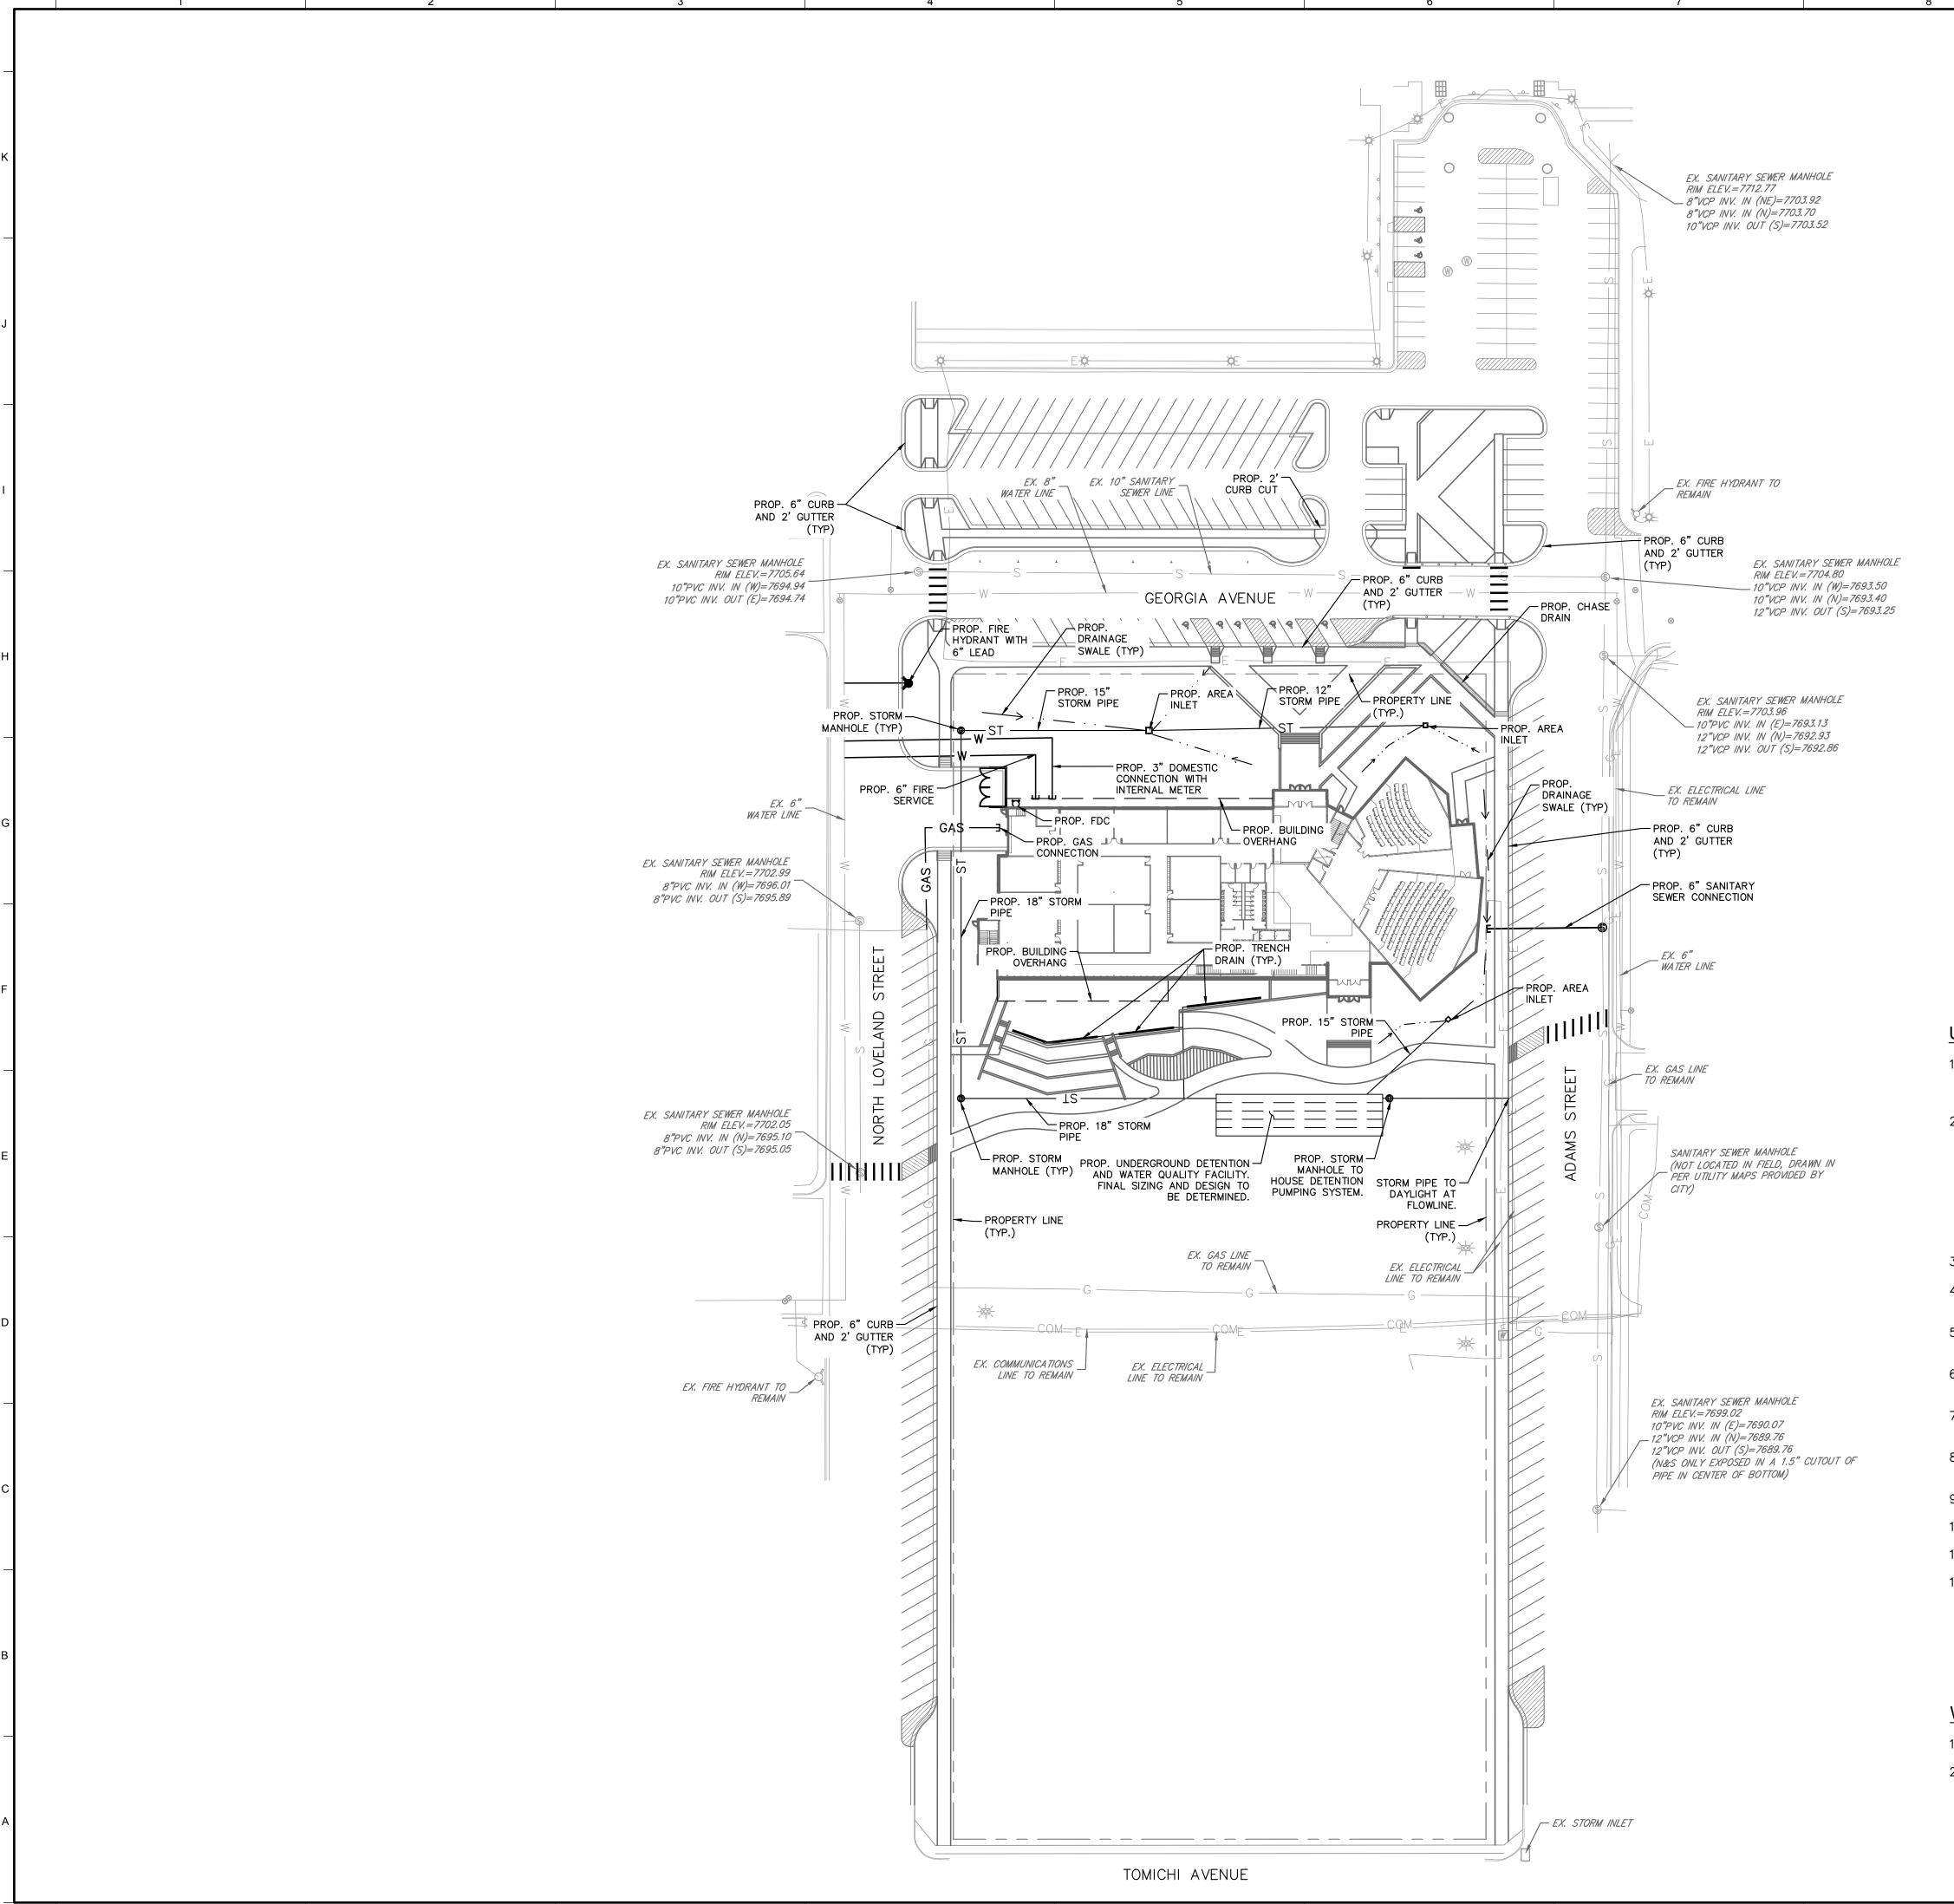

UTILITY LEGEND

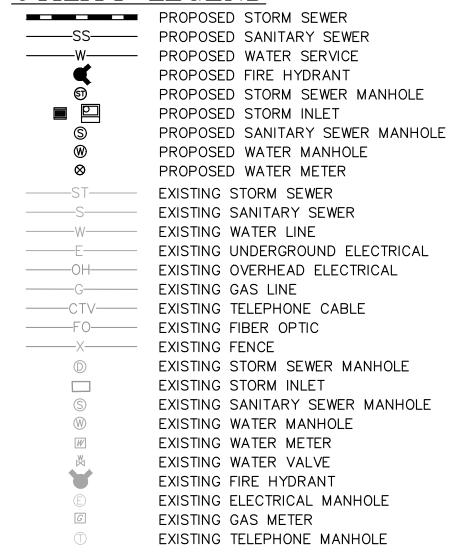

UTILITY NOTES

- 1. CONTRACTOR IS RESPONSIBLE FOR DEMOLITION OF EXISTING STRUCTURES INCLUDING REMOVAL OF ANY EXISTING UTILITIES SERVING THE STRUCTURE. UTILITIES ARE TO BE REMOVED TO THE RIGHT-OF-WAY.
- 2. THE CONTRACTOR IS SPECIFICALLY CAUTIONED THAT THE LOCATION AND/OR ELEVATION OF EXISTING UTILITIES AS SHOWN ON THESE PLANS IS BASED ON RECORDS OF THE VARIOUS UTILITY COMPANIES, AND WHERE POSSIBLE, MEASUREMENTS TAKEN IN THE FIELD. THE INFORMATION IS NOT TO BE RELIED ON AS BEING EXACT OR COMPLETE. THE CONTRACTOR MUST CALL THE APPROPRIATE UTILITY COMPANIES AT LEAST 72 HOURS BEFORE ANY EXCAVATION TO REQUEST EXACT FIELD LOCATION OF UTILITIES. IT SHALL BE THE RESPONSIBILITY OF THE CONTRACTOR TO RELOCATE ALL EXISTING UTILITIES WHICH CONFLICT WITH THE PROPOSED IMPROVEMENTS SHOWN ON THE PLANS.
- 3. WATER LINES ARE ASSUMED TO HAVE 4.5' OF COVER AT CROSSINGS.
- 4. ALL EXISTING DRY UTILITIES HAVE BEEN ASSUMED TO BE 3' DEEP AT CROSSING LOCATIONS. CONTRACTOR TO NOTIFY ENGINEER OF ANY CONFLICTS.
- 5. CONTRACTOR TO FIELD VERIFY DEPTH AND LOCATION OF ALL EXISTING UTILITIES PRIOR TO CONSTRUCTION AND SHALL NOTIFY ENGINEER OF ANY CONFLICTS.
- 6. ALL STORM PIPE ENTERING STRUCTURES SHALL BE GROUTED TO ASSURE CONNECTION AT STRUCTURE IS WATERTIGHT.
- 7. CONSTRUCTION SHALL COMPLY WITH ALL APPLICABLE GOVERNING CODES AND BE CONSTRUCTED TO SAME.
- 8. CONTRACTOR TO FLUSH AND VACUUM ENTIRE ON-SITE STORMWATER SYSTEM UPON COMPLETION OF PROPOSED WORK.
- 9. ALL PVC TO BE SDR-35 UNLESS OTHERWISE NOTED.
- 10. REFER TO LANDSCAPE PLANS FOR TREE AND IRRIGATION INFORMATION.
- 11. REFER TO MEP PLANS FOR LIMITS OF DRY UTILITY REMOVAL AND RELOCATION.
- 12. ELECTRICAL DESIGN AND COORDINATION IS BY OTHERS; CONTRACTOR TO COORDINATE.

WATER QUALITY NOTE

- 1. PERVIOUS PAVERS TO PROVIDE REQUIRED WATER QUALITY CAPTURE VOLUME.
- 2. REFERENCE INCLUDED EXHIBIT FOR WATER QUALITY VOLUME CALCULATIONS





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MESA PROPERTIES

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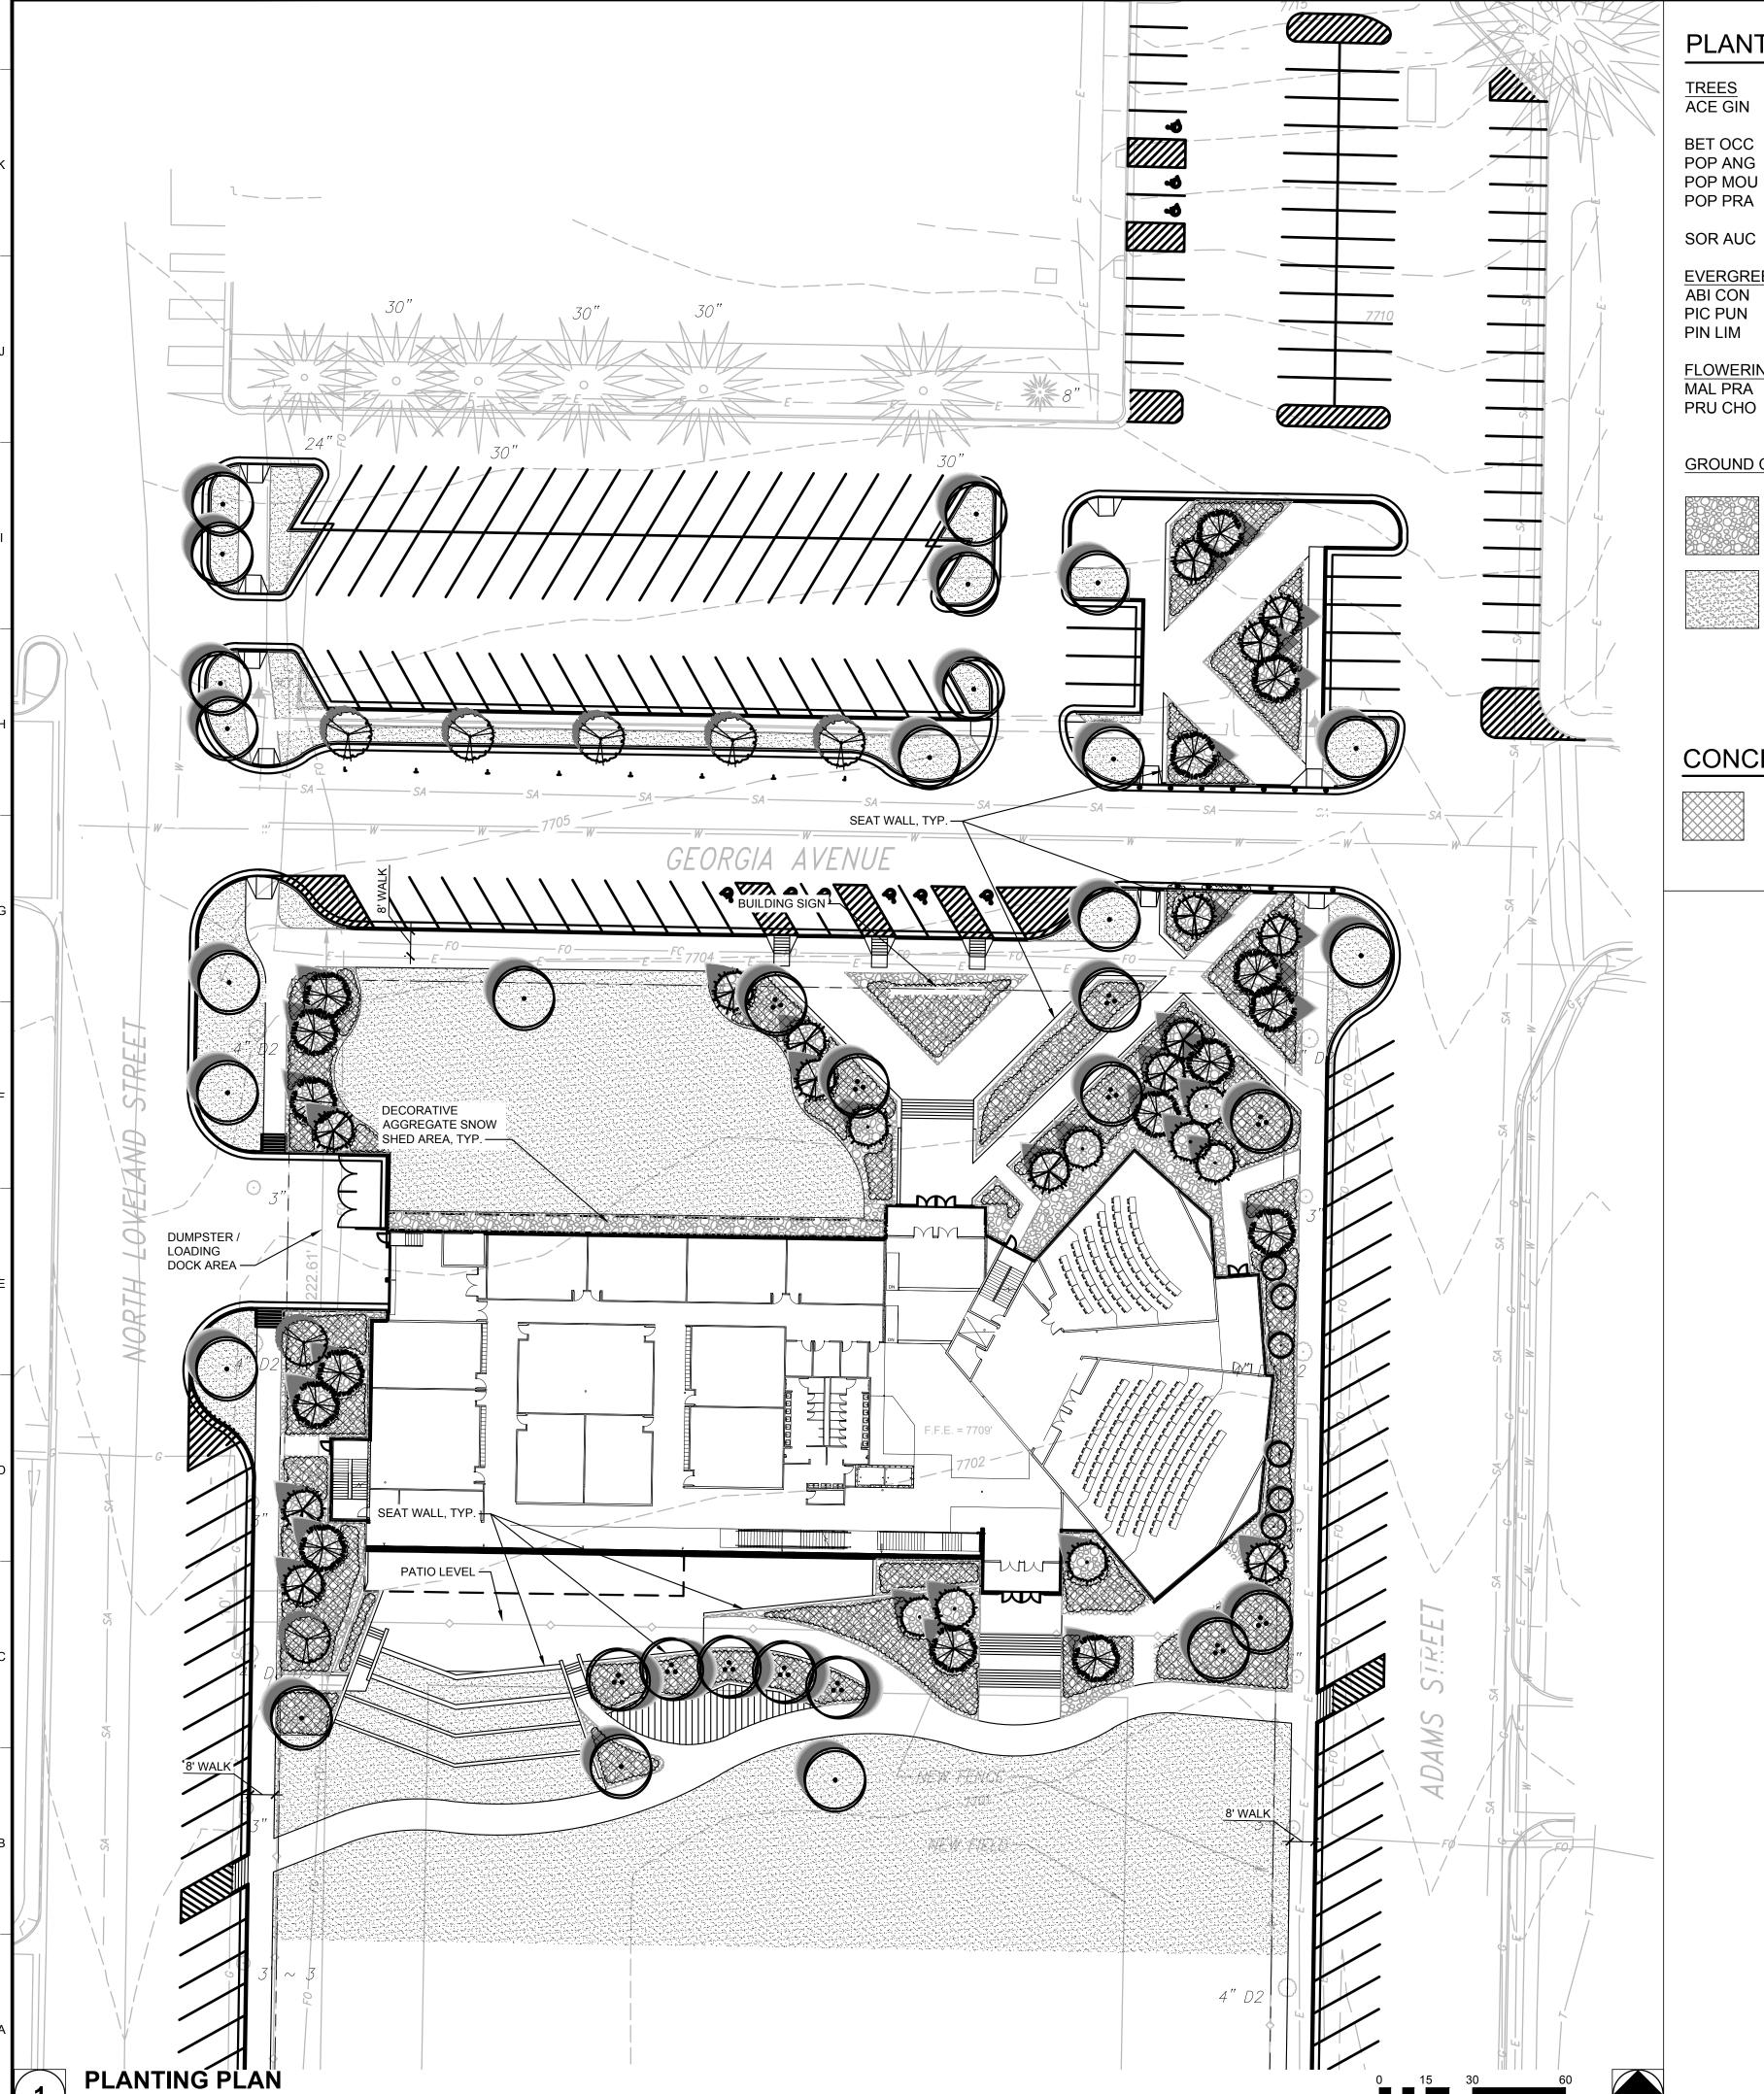
DATE:	07/05/2018
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REVIEWED:	DMS

PRELIMINARY UTILITY PLAN

SDP-05

0180432.00

PROJECT NO.:



SCALE: 1"=30'

PLANT SCHEDULE

_						
	TREES	QTY 3	BOTANICAL NAME	COMMON NAME	SIZE	
	ACE GIN	3	Acer ginnala `Flame` Multi-Stem	Flame Amur Maple	8` Tall	
	BET OCC	3	Betula occidentalis	Water Birch	7` Tall	
	POP ANG	14	Populus angustifolia	Narrowleaf Poplar	2" Cal	
	POP MOU	6	Populus tremuloides `JFS-Column`	Mountain Sentinel Quaking Aspen	1.5" Cal	
	POP PRA	6	Populus tremuloides `Prairie Gold` CLUMP FORM	Prairie Gold Aspen	8` Tall	
	SOR AUC	6	Sorbus aucuparia	European Mountain Ash	2" Cal	
	EVERGREEN TREES	<u>QTY</u> 16	BOTANICAL NAME	COMMON NAME	SIZE	
	ABI CON		Abies concolor	White Fir	8` Tall	
	PIC PUN	8 15	Picea pungens `Hoopsii`	Hoopsi Blue Spruce	7` Tall 8` Tall	
	PIN LIM	15	Pinus flexilis `Vanderwolf`s Pyramid`	Vanderwolf`s Pyramid Limber Pine	o raii	
	FLOWERING TREES	QTY	BOTANICAL NAME	COMMON NAME	SIZE	
	MAL PRA	QTY 6	Malus x `Prairifire`	Prairifire Crab Apple	1.5" Cal	
	PRU CHO	1	Prunus virginiana `Canada Red`	Canada Red Chokecherry	1.5" Cal	
	GROUND COVERS	CODE	QTY	BOTANICAL NAME	COMMON NAME	SIZE
		MULCH 2	22,838 sf	River Rock Aggregate Mulch 3" Depth		mulch
		TUR SEE	40,311 sf	Turf Seed	Tall Fescue Mix	Seed

CONCEPT PLANT SCHEDULE

U.S. SURVEY FEET

NATIVE SHRUBS / GROUNDCOVERS / PERENNIALS 10,762 sf

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- 1 06/08/2018 SDP SUBMITTAL #1
- 2 07/05/2018 SDP SUBMITTAL #2

PROJECT:

MESA PROPERTIES

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OF COMPUTER
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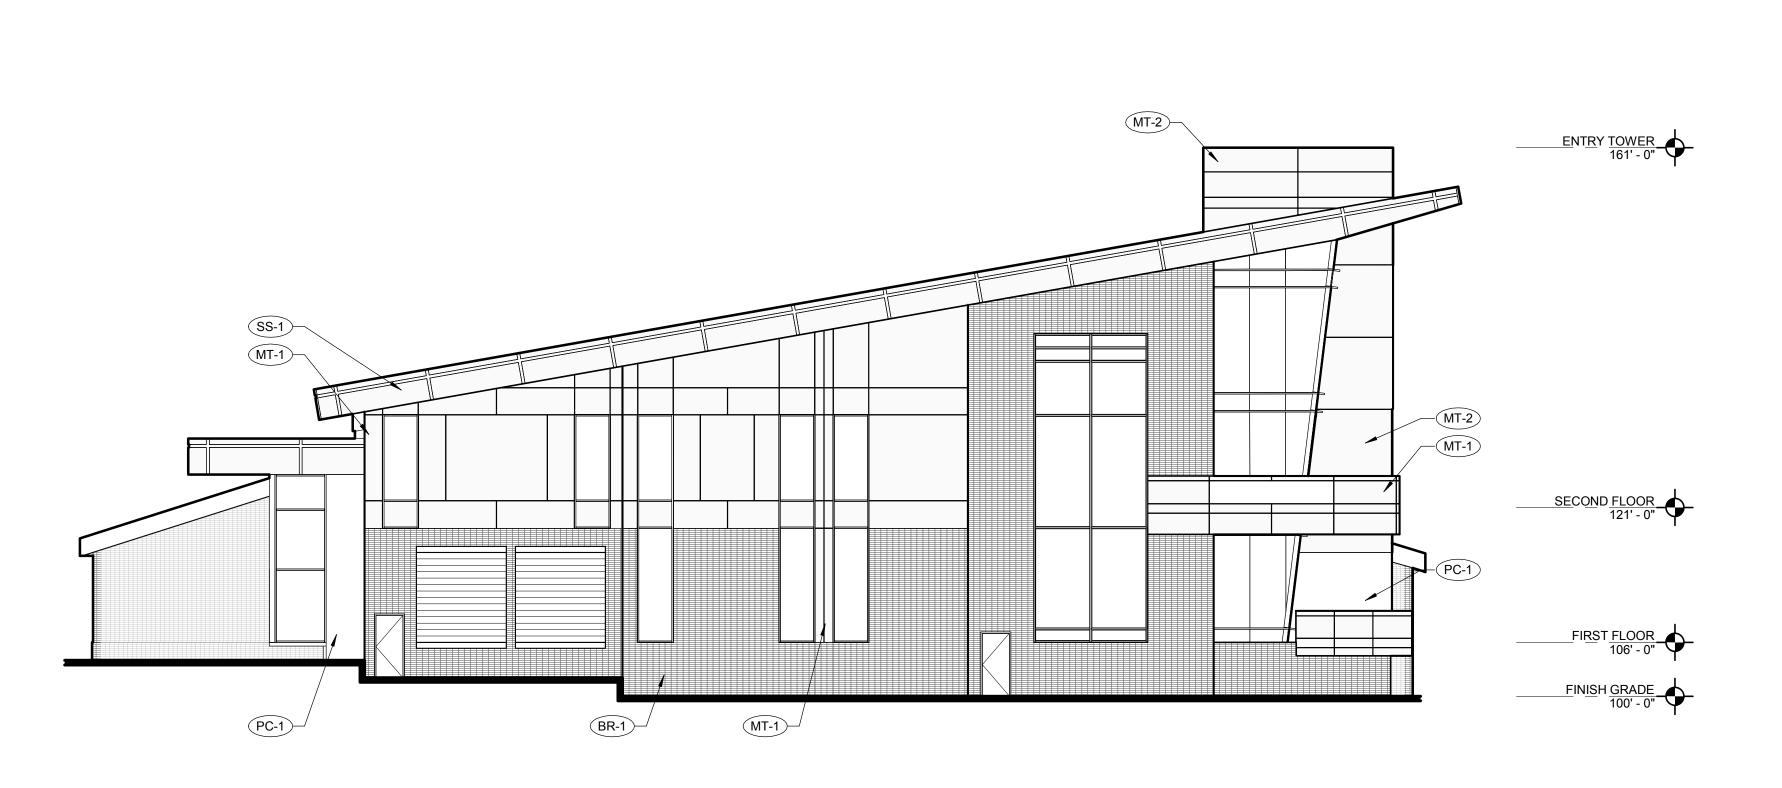
DATE:	07/05/2018
DESIGNED:	СН
DRAWN:	JLH
REVIEWED:	СН
FIELD BOOK NO.:	_

ET TITI E·

PLANTING PLAN

SDP-6

PROJECT NO.:



FINISH LEGEND		
KEY	STYLE	
BR-1	BRICK	
MT-1	METAL PANEL - COLOR 1	
MT-2	METAL PANEL - COLOR 2	
MT-3	METAL PANEL - COLOR 3	
PC-1	PRECAST CONCRETE	
SS-1	STANDING SEAM METAL - COLOR 1	
SS-2	STANDING SEAM METAL - COLOR 2	




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WEST ELEVATION



THE RADY COLLEGE OF COMPUTER SCIENCE AND **ENGINEERING AT** WSCU

777 GEORGIA AVE GUNNISON, CO

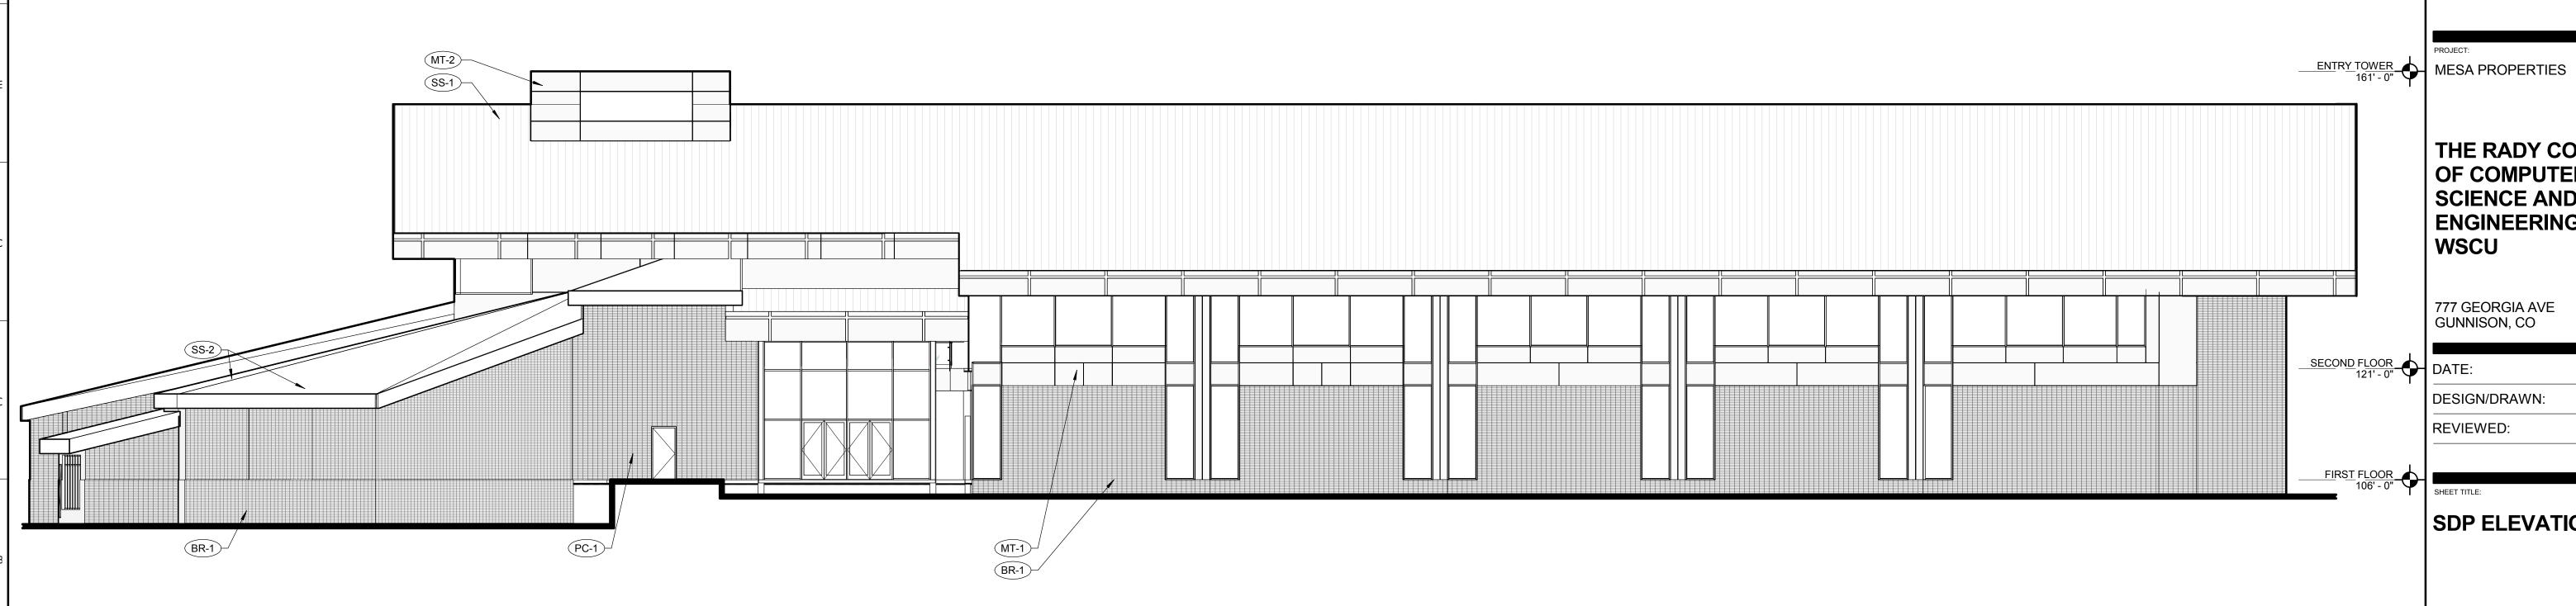05/08/2018 Designer REVIEWED: Approver


SDP ELEVATIONS

SDP-08

NORTH ELEVATION

Scale: 3/32" = 1'-0"

PROJECT NO.: 0180432.00

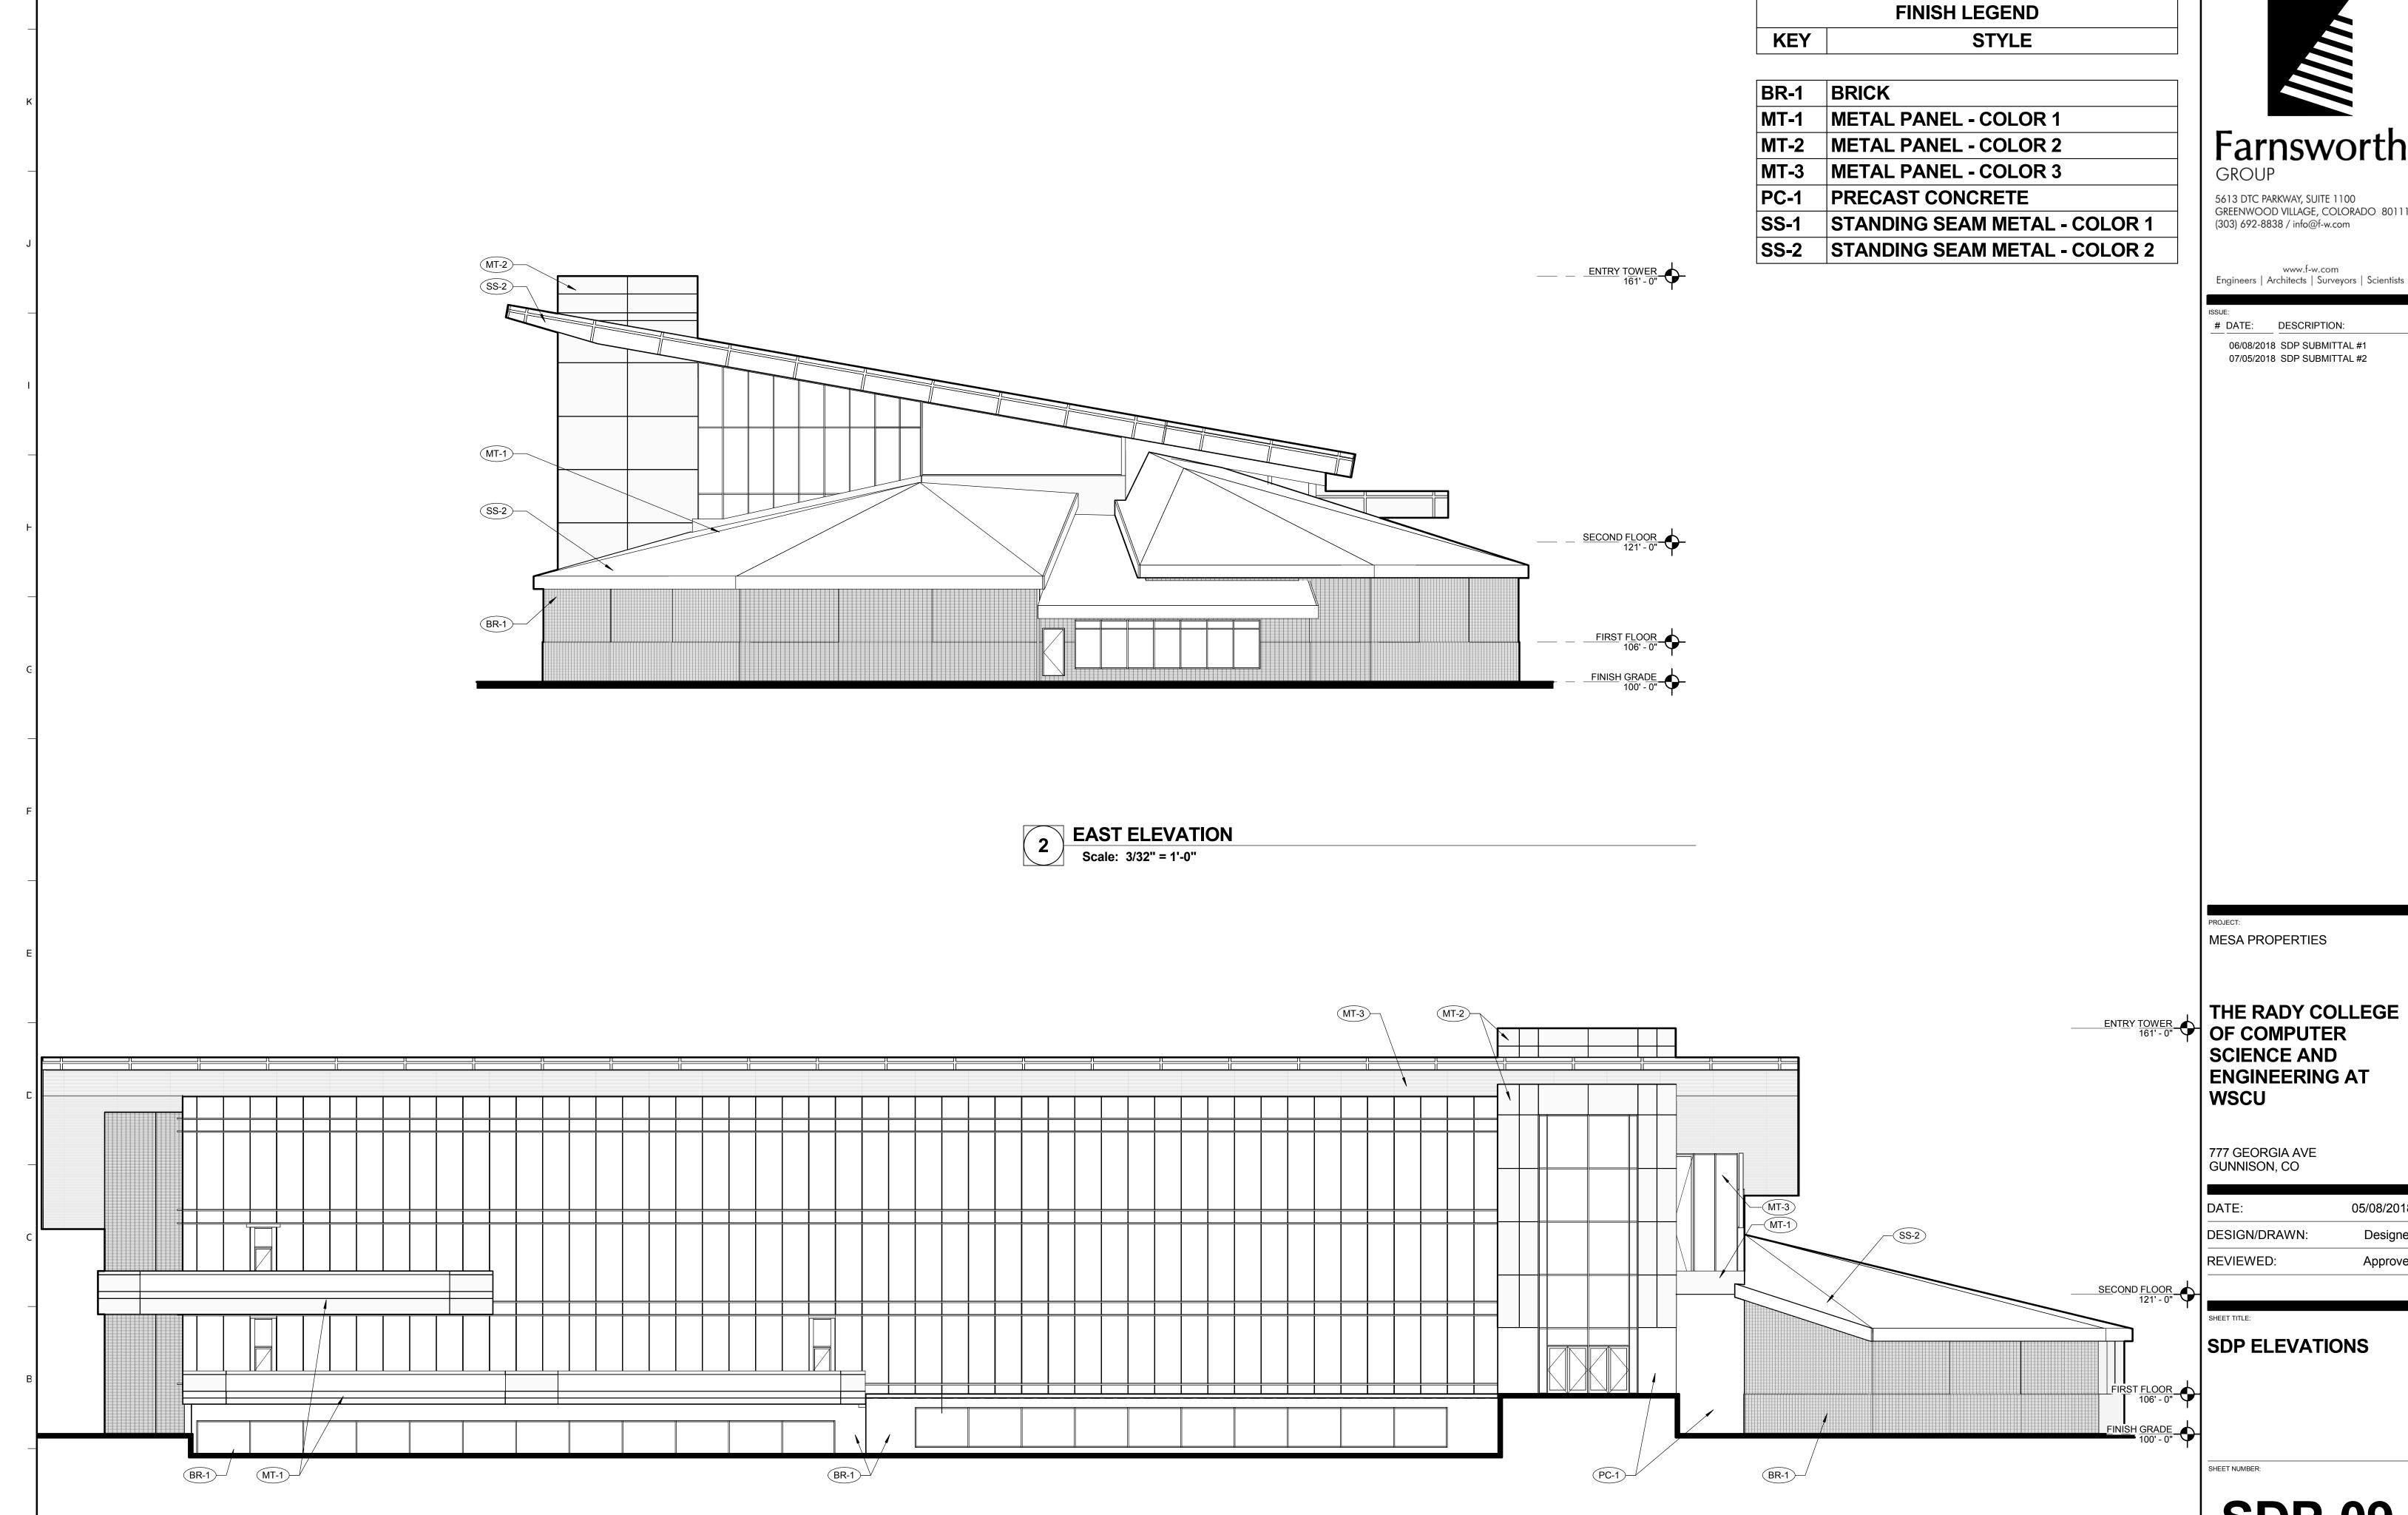

SOUTH ELEVATION

Scale: 3/32" = 1'-0"

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SDP-09

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